## CITY OF ELK GROVE SMUD SERVICES REQUEST FOR TELECOMMUNICATOINS SERVICE PROVIDER



Date of Request:	ĸ
Approximate Date Service Connection is No	eeded:
START X DISCONNECT	TRANSFER OF SERVICE

Telecommunications Service Provider (TSP) Name: AT&T

TSP Billing Address: AT&T Mobility c/o Engie Insight MS 7372 P.O. Box 2241 Spokane, WA 99210

TSP Tax ID:

Contact Person and Number: Engie Insight (866) 322-4547

Point of Connection (POC): City Service#: Not Available

SMUD POC to City Conductor:

 Descriptive Address: Measurements must be from the street center line and must be listed as x feet, the side of the street, and include north/south and east/west directions. For example: 50 feet of East Street and 10 feet South of J Street.

Meter #: 2005873

Address: 8407 Greentrails Way, Elk Grove, CA 95624

Description: East side of Power Inn Rd 40 feet from the centerline; 68 feet North from the centerline of Villa Serena Drive.

2. California State, Zone 2, NAD83 in Feet: X,Y coordinate of the connection point:

NAD83:0402, 6735521.049ftUSE 1925008.868ftUSN
Decimal: 38.446502,-121.392964

 Attach City Map with SMUD POC to City Conductor with an X or highlight on the map. (Note: please only submit the drawing with this location. Do not submit all drawing pages.) City Pole Number: Pole #: SLT-35222L

Location of TSP Devices on City Street lights:

- 1. Descriptive Address: Measurements must be from the street center line and must be listed as x feet, the side of the street, and include north/south and east/west directions. For example: 50 feet of East Street and 10 feet South of J Street.

  Address: 8611 Power Inn Rd Description: North 42 Feet from the centerline of Power Inn Rd.; 1,126 Feet East from the centerline of Auberry Drive
- 2. California State, Zone 2, NAD83 in Feet: X,Y coordinate of the connection point: NAD 83: Zone 0402, 6734761.854ftUSE 1925558.102ftUSN Decimal: 38.448024, -121.395602
- 3. California State, Zone 2, NAD83 in Feet: X,Y coordinate of the connection point where the antenna is being powered from:

  NAD 83: 0402 6735538.223ftUSE 1925010.439ftUSN

Decimal: 38.446506, -121.392904

Attach City Map with locations of 1) TSP devices on City Street light with an X or highlight on the map and 2) where the device is getting power from. (Note: please only submit the drawing with these locations. Do not submit all drawing

Number/Type of Devices: (How many transmitters, antennae, etc.)

2 Transmitters (RRU's) and 1 antenna

Make and Model of Devices:

Ericsson RRU 4415, Ericsson RRU 4426, Commscope VVSSP-360S-F

Maximum Nameplate AC Wattage of each Device:

Ericsson RRU 4415 = 1100W, Ericsson RRU 4426 = 1100W

Small cell attachment equipment specification sheet attached X

This area reserved for SMUD use only

pages.)





## **SMALL CELL LOAD SUMMARY – Elk Grove**

Vendor Name: Vinculums City Project Number: Date: 11/4/19

	Project:			sai Et						
	Location Address:	8661 POWER INN RD								
	38.448024, -121.395602 City Service Coordinates: 38.44			38.446506, -1	121.392904					
	SAC01_017									
Street	Light Pole Number:	SLT-35222L (MA-LED)								
C	ity Service Address:	8407 Greentrai	ls Wa	ıy, Elk Grov	e, CA 9	5624				
SMU	D Point of Connect:	Meter #200587	3							
CI	ty Service Number:	Need Service Number from City								
	RF Config:			Radio Load: 2200W Fu		Future	ture Radio Load:			
	Circuit Breaker:	Position #3, Lighting 3; 40 AMP								
	Voltage:	⊠ 120 V □ 240 V □ 277 V □ 480 V								
		MA-LED:		4	ORI	N-LED:			PT-LED:	
Numbe	er of Existing Loads:	MA-HPS:			OR	N-HPS:			PT-HPS:	
Description of Exis	sting Loads (Street Ligh	it Numbers):						J. 175		
35222L	35222M	35222F		35222G						
						141				

	ng Loads	Total Exist
440 W	MA-LED X 110 W	4
w	MA-HPS X 200 W	
w	ORN-LED X 110 W	
w	ORN-HPS X 100 W	
w	PT-LED X 110 W	
w	PT-HPS X 100 W	
2200 W	Radio Load	
2640 W	New Load Total (RP):	
3.3 KVA	Total Load on Circuit:	7
27.5AMP	linimum Circuit Overcurrent Protection Required:	*/
19,272	Radio Load Pico kWh/Yr.:	

Recircuiting Required:					
☐ Yes ⊠ No					
Existing Circuit Breaker 40 AMPS					
Percentage Overcurrent Protection Used			5		
Difficulty Level	1				
1. No Constructability Issues	2. Difficult 3. Very Dif		3. Very Difficult		
Pass or Fail:	□ Pass □ Fail				
Notes:		7			
*Per NEC Regulation, the Real Power (RP) will not exceed 80% of the Overcurrent Protection.					

Street L	ight No.	G	PS		ight Typ	e	Comments
Site Pole	Others	Latitude	Longitude	Lamp Post	Post Top	Mast Arm	(LED, HPS, SIGNAL, COBRA, ETC.)
35222L	x	38.44812	-121.395609			х	EDL
	35222M	38.447974	-121.397138			х	LED
	35222F	38.446949	-121.393743			х	LED
	35222G	38.447727	-121.394764			х	LED



# Penso Engineering Joshua Penso, PE-EE

Date: 11/20/2019

To Whom It May Concern:

In coordination with RLS-CMC & Vinculum/AT&T drawings for node SAC01\_017. I have reviewed the OEM specifications for the proposed equipment listed below. Based on the data sheets for the equipment listed, I have calculated the power consumption, apparent power, and yearly usage listed for the typical radio equipment configuration powered solely by this equipment. This calculation is based on a single power supply powered by a 120V 2-wire service and all proposed radio loads will be powered only by this single supply.

Equipment	Description	Max Power (Watts)	Max Current (Amps)	KVA	KWh/Yr
PSU AC 08	Rectifier Power Supply	2200	18.34	2.2	19272

I, Joshua Penso, affirm that the design presented in this document meets the 2016 California Electric Code, the 2014 NEC and the 2014 National Electric Safety Code (NESC).

Sincerely,

Joshua Penso, PE-EE

California License E-16741

Expiration Date: 9/30/2020

11 - 20 - 19



SITE ID: CRAN\_RSFR\_SAC01\_017

NODE FA: 14807730 NODE USID: 187849

PACE: MRSFR044371

IN THE PUBLIC R.O.W.

**ADJACENT TO 8661 POWER INN RD** 

**ELK GROVE, CA 95624** 

STREET LIGHT ID #: 352221

PROJECT TYPE: MICRO

## **CONSULTING TEAM**

#### ENGINEERING COMPANY:

M SQUARED WIRELESS 1387 CALLE AVANZADO SAN CLEMENTE, CA 92673 CONTACT: MICHAEL MONTELLO CONTACT: DIAN TARDIFF PHONE: (949) 391-6824

VINCULUMS SERVICES 1200 DEL PASO RD, STE 150 SACRAMENTO, CA 95843 PHONE: (209) 662-4217 EMAIL: DTARDIFF@VINCULUMS.COM

PLANNING CONSULTANT:

#### CONSTRUCTION MANAGER:

VINCULUMS SERVICES 1200 DEL PASO RD, STE 150 SACRAMENTO, CA 95843 CONTACT: ROBERT FLYNT PHONE: (916) 768-9699 EMAIL · RELYNT@VINCULUMS COM

## DO NOT SCALE **DRAWINGS**

UBCONTRACTOR SHALL VERIFY AL! SUBCONTRACTOR SHALL VERIFY ALL PLANS, EXISTING DIMENSIONS & FIELD CONDITIONS ON THE JOB SITE & SHALL IMMEDIATELY NOTIFY THE ENGINEER IN WRITING OF ANY DISCREPANCIES BEFORE PROCEEDING WITH THE WORK OR RESPONSIBLE FOR SAME




Call Two Working Days Before You Dig! 811 / 800-227-2600 usanorth.org

### **APPLICABLE CODES**

ALL WORK AND MATERIALS SHALL BE PERFORMED AND INSTALLED IN ACCORDANCE WITH THE CURRENT EDITIONS OF THE FOLLOWING CODES AS ADOPTED BY THE LOCAL GOVERNING AUTHORITIES.

- CALIFORNIA ADMINISTRATIVE CODE (INCL TITLE 24 & 25)
- 2016 CALIFORNIA BUILDING CODE
- 2016 MECHANICAL CALIFORNIA CODE 2016 CALIFORNIA ELECTRICAL CODE
- 2016 GREEN BUILDING CODE
- 2016 CALIFORNIA ENERGY CODE
- GENERAL ORDER 95 (JUNE 2009 EDITION)
   CURRENT SACRAMENTO CITY CODE AMENDMENTS

### **VICINITY MAP**

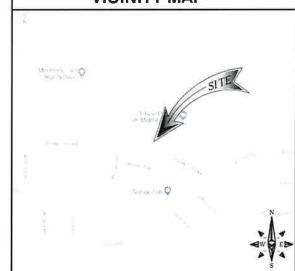

## **CONTRACTOR NOTES**

CONTRACTOR SHALL VERIFY ALL PLANS, EXISTING DIMENSIONS AND CONDITIONS ON THE JOB SITE AND SHALL IMMEDIATELY NOTIFY THE ARCHITECT AND/OR ENGINEERS IN WRITING OF ANY DISCREPANCIES BEFORE PROCEEDING WITH THE WORK OR BE RESPONSIBLE FOR THE SAME.

#### **DRIVING DIRECTIONS**

IRECTIONS FROM SACRAMENTO INTERNATIONAL AIRPORT:

- GET ON I-5 S FROM AVIATION DR AND AIRPORT BLVD
- CONTINUE ON 1-5 S
  TAKE CA-99 S TO CALVINE RD IN SACRAMENTO
  TAKE EXIT 289 FROM CA-99 S
- DRIVE TO POWER INN RD IN ELK GROVE
- USE LEFT 2 LANES TO TURN LEFT ONTO CALVINE RD
- TURN RIGHT ONTO POWER INN RD
- DESTINATION WILL BE ON THE RIGHT

## POLE # 352221



#### PROJECT INFORMATION

OWNER: CITY OF ELK GROVE

APPLICANT:

5001 EXECUTIVE PARKWAY SAN RAMON, CA 94583

115-0150-077 ADJACENT APN#:

LATITUDE: 38' 26' 52 9"N 38 448024"

LONGITUDE: 121° 23' 44.2"W -121.395602'

JURISDICTION: CITY OF ELK GROVE

PUBLIC RIGHT-OF-WAY PROPOSED USE:

UNMANNED TELECOMMUNICATIONS FACILITY

POWER COMPANY SMUD

## **PROJECT DESCRIPTION**

THIS IS UNMANNED WIRELESS TELECOMMUNICATION FACILITY FOR AT&T MOBILITY CONSISTING OF THE INSTALLATION AND OPERATION OF AN ANTENNA AND ASSOCIATED EQUIPMENT ON AN (E) STREET LIGHT POLE IN THE PUBLIC RIGHT OF WAY. SCOPE OF WORK & SITE COMPLÉTION CHECKLIST:

- INSTALL A (N) TELECOMMUNICATION ANTENNA & EQUIPMENT BOXES ON AN (E) STREET LIGHT POLE. INSTALLATION CONSISTS OF (1) CYLINDRICAL ANTENNA IN A 10-1/2"ø FIBERGLASS SHROUD WITH A 10-3/4"ø CAP & (1) RRUS-4426, (1) RRUS-4415 & (2) DIPLEXERS
- DURABLE PAINT ANTENNA SHROUD, CABLING & RADIO RELAY UNITS TO BE PAINTED TO MATCH (E) STREET LIGHT POLE USING A DURABLE PAINT (E:G: SHERWIN WILLIAMS FRAZEE OR EQUIVALENT)
- CABLING CABLING TO BE INSTALLED IN A TIDY MANNER WITHOUT EXCESS CABLE
- SPACING OF SUPPORT ELEMENTS SUPPORT EQUIPMENT (E.G. RRUS) TO BE CLUSTERED AS CLOSE AS TECHNICALLY FEASIBLE ON POLE.
- LOGO REMOVAL ALL EQUIPMENT LOGOS, OTHER THAN THOSE REQUIRED BY REGULATION (E.G. NODE IDENTIFICATION OR SHUTDOWN SIGNAGE) OR PG&E REGULATIONS SHALL BE PAINTED OVER OR REMOVED. RAISED/DEPRESSED LOGOS/TEXT ON RRUS OR OTHER EQUIPMENT, IF PRESENT, TO BE SANDED OFF OR SIMILARLY REMOVED/ FILLED.
- UTILITY LINES PROPOSED UTILITY LINES BETWEEN (E) POINT OF CONNECTION TO
- INSTALL (1) NEW COMMERCIAL METER PEDESTAL;
- INSTALL (1) NEW PULLBOX & CONDUITS FOR ASSOCIATED POWER & FIBER.

SHEET	DESCRIPTION			
T-1	TITLE SHEET			
A-1	SITE PLAN			
A-2	ENLARGED SITE PLAN			
A-3	ELEVATIONS			
D-1, D-2, D-3	EQUIPMENT DETAILS			
E-1, E-2	ELECTRICAL DETAILS			
TCP-1	TRAFFIC CONTROL PLAN NOTES			
TCP-2	TRAFFIC CONTROL PLAN			







LOCATION NO:	14807730
DRAWN BY:	EZG
CHECKED BY:	ММ

î.	12/04/2019	100% CD'S FOR SUBMITTAL
D	11/21/2019	100% CD'S FOR REVIEW
В	11/01/2019	95% CD'S FOR RÉVIEW
Α	09/16/2019	90% CD'S FOR REVIEW
REV	DATE	DESCRIPTION


I IS A VIOLATION OF LAW FOR ANY PERSON, UNLESS EY ARE ACTING UNDER THE DIRECTION OF A LICENSE PROFESSIONAL ENGINEER, TO ALTER THIS DOCUMENT,

CRAN\_RSFR\_SAC01\_017

POLE # 352221 IN THE PUBLIC ROW 8661 POWER INN RD ELK GRCVE, CA 95624

SHEET TITLE

TITLE SHEET

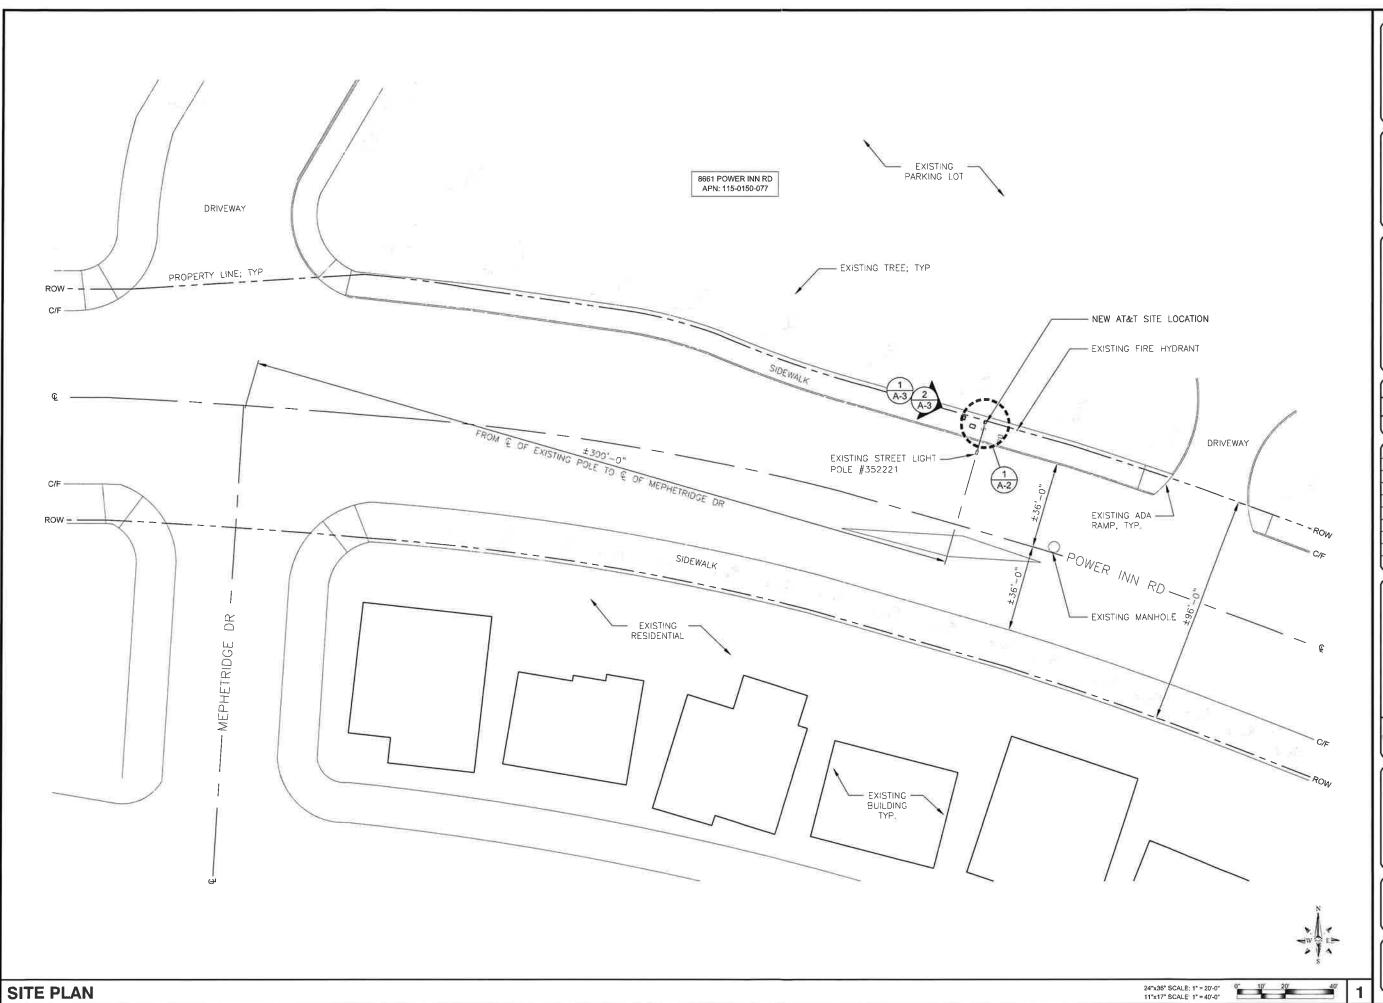







LOCA	OCATION NO: 14807730				
DRAV	DRAWN BY: EZC				
CHE	CKED BY:	мм			
$\equiv$					
1	12/04/2019	100% CD'S FOR SUBMITTAL			
0	11/21/2019	100% CD'S FOR REVIEW			
В	11/01/2019	95% CD'S FOR REVIEW			
А	09/16/2019	90% CD'S FOR RÉVIEW			
REV	DATE	DESCRIPTION			

IT IS A VIOLATION OF LAW FOR ANY PERSON, UNLESS
HEY ARE ACTING UNDER THE DIRECTION OF A LICENSE(
PROFESSIONAL ENGINEER, TO ALTER THIS DOCUMENT

CRAN\_RSFR\_SAC01\_017


POLE # 352221 IN THE PUBLIC R.O.W. 8661 POWER INN RD ELK GROVE, CA 95624

SHEET TITLE

SITE PLAN

SHEET NUMBER

A-1

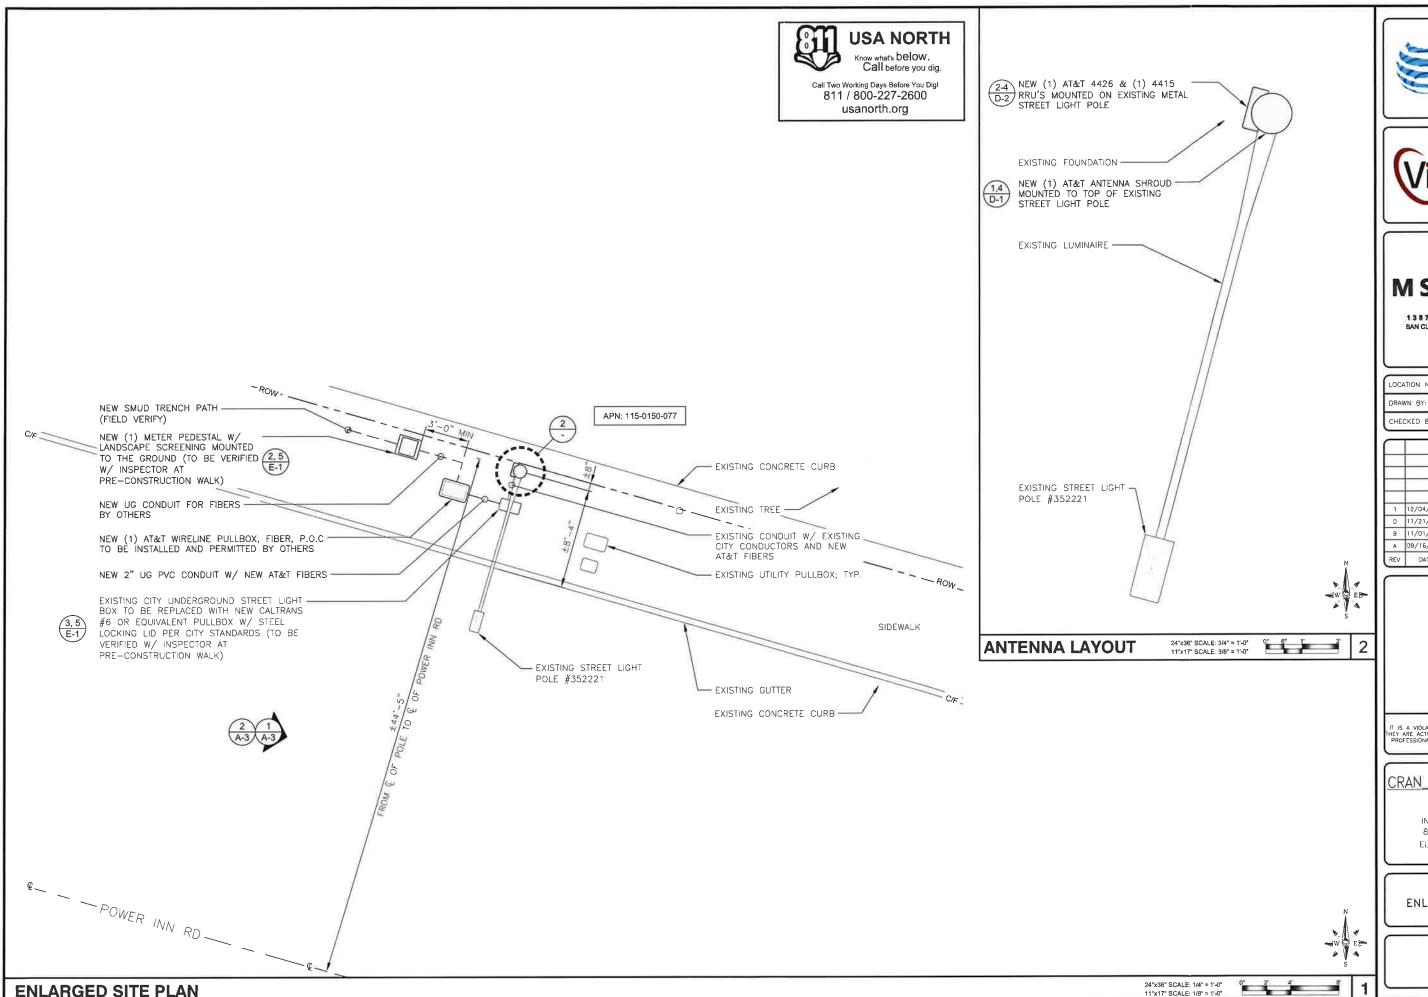







l	LOCATION NO:	14807730
П	DRAWN BY:	EZG
	CHECKED BY:	мм

_		
1	12/04/2019	100% CD'S FOR SUBMITTAL
D	11/21/2019	100% CD'S FOR REVIEW
В	11/01/2019	95% CD'S FOR REVIEW
Α	09/16/2019	90% CD'S FOR REVIEW
REV	DATE	DESCRIPTION

IT IS A VIOLATION OF LAW FOR ANY PERSON, UNLESS THEY ARE ACTING UNDER THE DIRECTION OF A LICENSE! PROFESSIONAL ENGINEER, TO ALTER THIS DOCUMENT.

CRAN\_RSFR\_SAC01\_017

POLE # 352221
IN THE PUBLIC R.O.W.
8661 POWER INN RD
ELK GROVE, CA 95624

SHEET TITLE

ENLARGED SITE PLAN

SHEET NUMBER

**A-2** 



ALL NEW EQUIPMENT TO BE PAINTED TO MATCH EXISTING POLE COLOR USING DURABLE NON-REFLECTIVE PAINT (E.G. SHWERWIN WILLIAMS, FRAZEE OR EQUIVALENT)







LOCATION NO:	14807730		
DRAWN BY:	EZG		
DRAWN BY: CHECKED BY:	MN		

1	12/04/2019	100% CD'S FOR SUBMITTAL
0	11/21/2019	100% CD'S FOR REVIEW
В	11/01/2019	95% CD'S FOR REVIEW
Α	09/16/2019	90% CD'S FOR REVIEW
REV	DATE	DESCRIPTION

IT IS A VIOLATION OF LAW FOR ANY PERSON, UNLESS HEY ARE ACTING UNDER THE DIRECTION OF A LICENSE PROFESSIONAL ENGINEER, TO ALTER THIS DOCUMENT.

## CRAN\_RSFR\_SAC01\_017


POLE # 352221 IN THE PUBLIC ROW 8661 POWER INN RD ELK GROVE, CA 95624


SHEET TITLE

POLE ELEVATIONS

SHEET NUMBER

**A-3** 

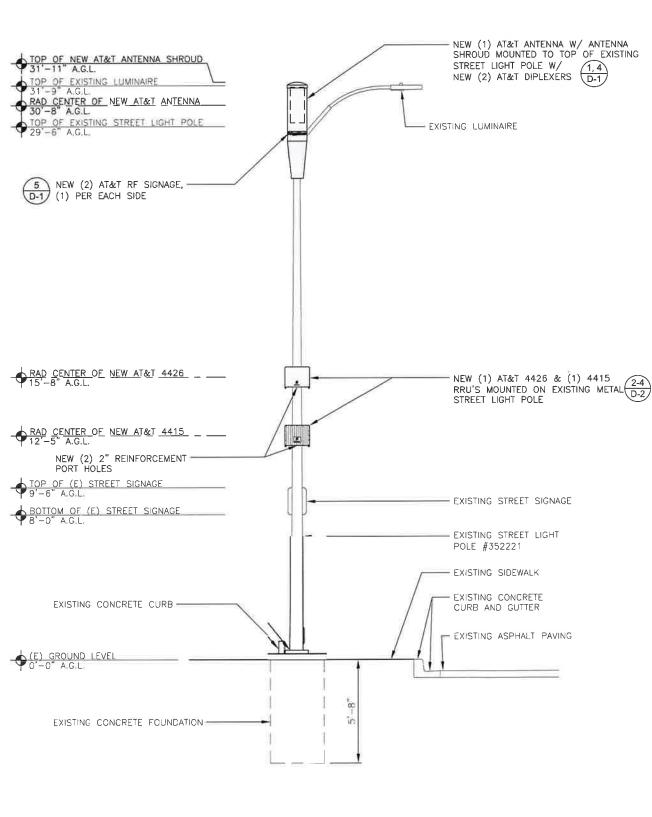

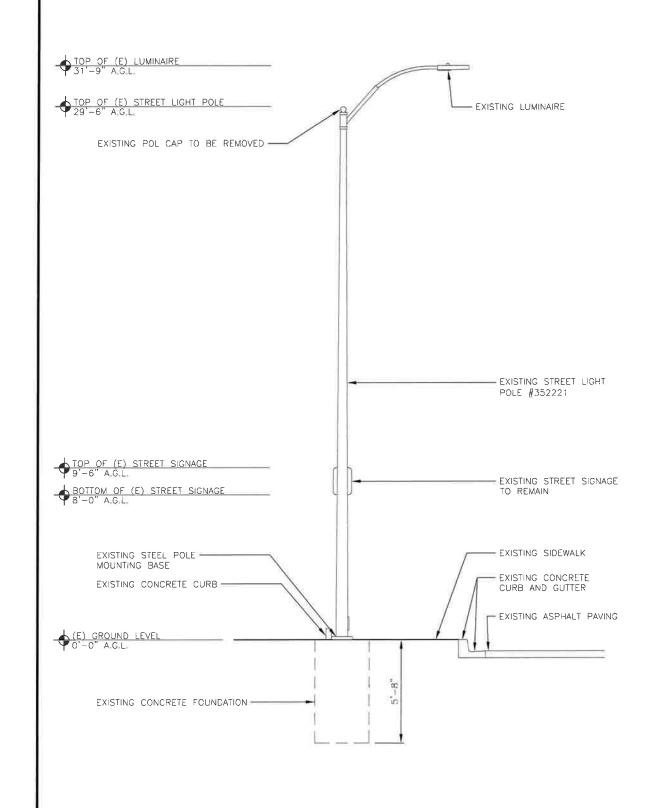


**EXISTING WEST ELEVATION** 


24"x36" SCALE 3/8" = 1'-0" 

2


NEW WEST ELEVATION

24"x36" SCALE 3/8" = 1'-0" 11"x17" SCALE 3/16" = 1'-0"

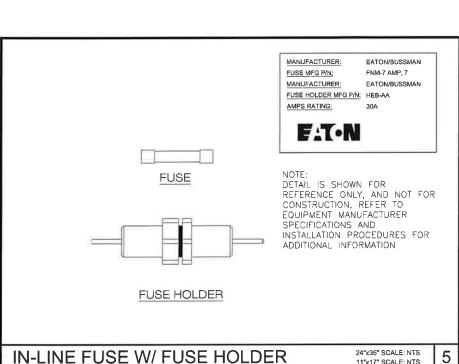

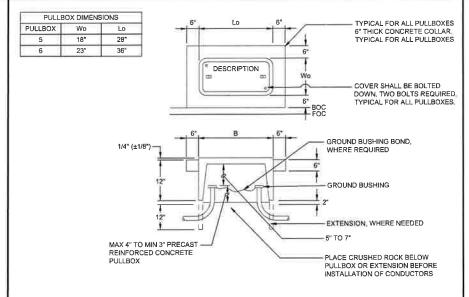

CALTRANS #5 OR # 6 PULLBOX

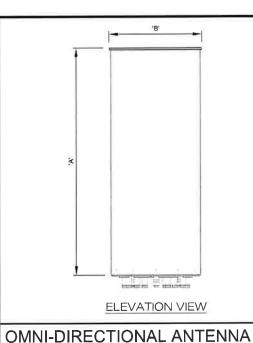

MAN	JFACTURER:	COMMSCOPE		
MOD	EL:	VVSSP-360S-F		
DIME	NSIONS			
Α	23.6"	TOTAL WEIGHT: 15.4 LBS		
В	7,9"	.5,4 650		

24"x36" SCALE: NTS

11"x17" SCALE: NTS







LOCATION NO:	14807730		
DRAWN BY:	EZG		
CHECKED BY:	MM		

1	12/04/2019	100% CD'S FOR SUBMITTAL
0	11/21/2019	100% CD'S FOR REVIEW
В	11/01/2019	95% CD'S FOR REVIEW
Α	09/16/2019	90% CD'S FOR REVIEW

IT IS A VIOLATION OF LAW FOR ANY PERSON, UNLESS HEY ARE ACTING UNDER THE DIRECTION OF A LICENSE PROFESSIONAL ENGINEER, TO ALTER THIS DOCUMENT.


CRAN\_RSFR\_SAC01\_017

POLE # 352221 IN THE PUBLIC R.O.W. 8661 POWER INN RD ELK GROVE, CA 95624

SHEET TITLE

EQUIPMENT DETAILS

SHEET NUMBER D-1

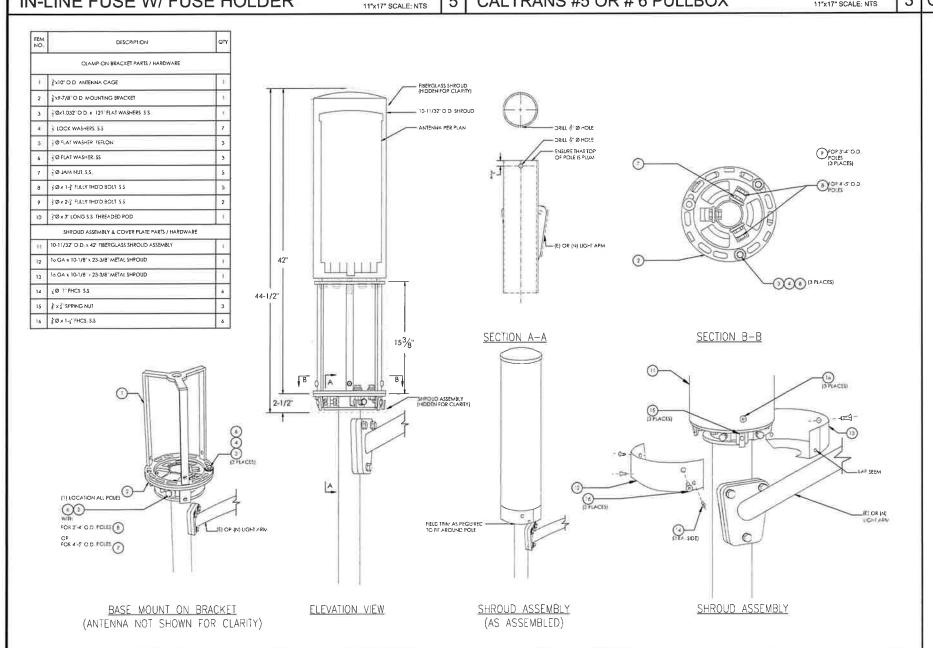

LIGHT STANDARD ANTENNA MOUNT FOR 3"-5" O.D. POLES

24"x36" SCALE: NTS 11"x17" SCALE: NTS

24"x36" SCALE: NTS 11"x17" SCALE: NTS

**NOT USED** 

2





**NOT USED** 


## NOTICE


RF energy emitted by this device may exceed the FCC's general public exposure limits. Stay at least 1 foot away from the device, Call AT&T at 800–638–2822, 9 then 3 for help if you need access within 1 foot

RF SIGNAGE 11"x17" SCALE: NTS




NOTE

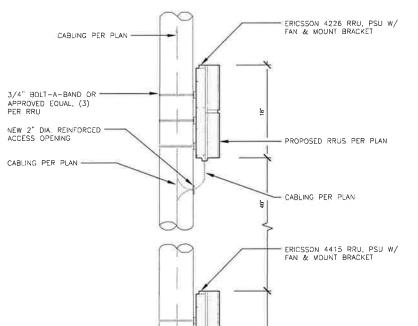

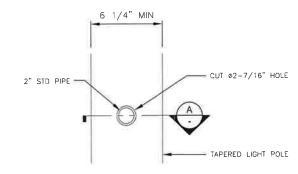

## **CUT DETAIL**

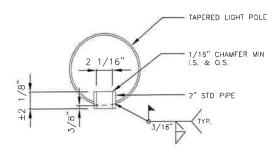

#### SECTION A-A

#### FIELD WELDING NOTES:

MANUFACTURER:

MODEL NO:

DIMENSIONS:

A 16.54"

B 13.50"

C 6.30"

- WELDING TO BE PERFORMED BY AN AWS CERTIFIED WELDER FOR THE TYPE OF AND POSITION INDICATED. ALL WORK MUST BE IN CONFORMANCE WITH LATEST EDITION OF ASIC & AWS D 1.1 CRIND SURFACES TO BE WELDED WITH A SILICONE CARBIDE WHEEL PRIOR TO WELDING TO REMOVE ALL GALVANIZING WHICH MAY OTHERWISE BE CONSUMED IN THE WELD METAL APPLY ANTI-SPATTER COMPOUND AFTER GRINDING.

  WELDING TECHNIQUE MUST MINIMIZE TEMPERATURE RISE ON THE INSIDE SURFACE OF THE MONOPOLE AND ALSO VOLATIZE ANY REMAINING ZINC WITHIN THE BASE METAL WITH MINIMUM SPATTER. USE AN E70 (LOW HYDROGEN) ELECTRODE. USE LARGEST DIAMETER ELECTRODE COMPATIBLE WITH WELDING POSITION AND MATERIAL THICKNESS. STRICTLY FOLLOW ALL MANUFACTURER'S INSTRUCTIONS FOR STRIPAGE AND LISE OF FLETRODES. STORAGE AND USE OF ELECTRODES. AVOID REMOVING ELECTRODES FROM MANUFACTURER'S PACKAGING UNTIL READY IMMEDIATE USE.
- WELDING MAY PRODUCE TOXIC TUMES. REFER TO ANSI STANDARD Z49.1 "SAFETY IN WELDING AND CUTTING" FOR PROPER PRECAUTIONS.
- CUTING FOR PROPER PRECAUTIONS.

  UPON COMPLETION OF WELDING, APPLY GALV-A-STICK ZINC COATING TO ALL UNPROTECTED SURFACES. APPLY A SECOND LAYER OF COLD GALVANIZING SPRAY COMPOUND CONTAINING A MINIMUM ZINC CONTENT OF 95%. IF NECESSARY, APPLY A FINAL COAT OF COMPATIBLE PAINT TO MATCH SURROUNDING SURFACES







LOCATION NO:	14807730
DRAWN BY:	EZG
CHECKED BY:	мм

1	12/04/2019	100% CD'S FOR SUBMITTAL
0	11/21/2019	100% CD'S FOR REVIEW
В	11/01/2019	95% CD'S FOR REVIEW
Α	09/16/2019	90% CD'S FOR REVIEW
REV	DATE	DESCRIPTION

IT IS A VIOLATION OF LAW FOR ANY PERSON, UNLESS HEY ARE ACTING UNDER THE DIRECTION OF A LICENSE PROFESSIONAL ENGINEER, TO ALTER THIS DOCUMENT,

## CRAN\_RSFR\_SAC01\_017

POLE # 352221 IN THE PUBLIC ROW 8661 POWER INN RD ELK GROVE, CA 95624


SHEET TITLE

EQUIPMENT DETAILS

SHEET NUMBER

**D-2** 

24X30°SCALE:NIS II 2 I A COECC DODTC			_			_	$\tau$
	6	RRU MOUNTING DETAIL	 3	ACCESS PORTS	24"x36" SCALE: NTS 11"x17" SCALE: NTS		1

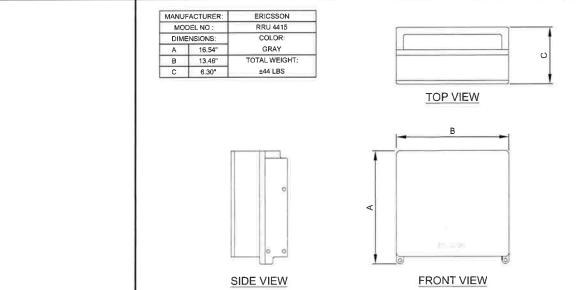

NEW 2"Ø REINFORCED = ACCESS OPENING

CABLING PER PLAN -



ERICSSON

RRU 4426

COLOR

GRAY

TOTAL WEIGH

±46 LBS

**ERICSSON RRU 4415 NOT USED** 

- CABLING PER PLAN

24"x36" SCALE: NTS 11"x17" SCALE: NTS


**ERICSSON RRU 4426** 

24"x36" SCALE: NTS


TOP VIEW

FRONT VIEW



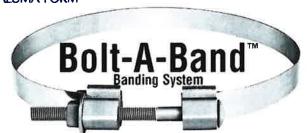


## For Mounting Equipment on Most Steel, Wood, or Concrete Poles

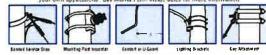

#### **How to Select Proper Size**

**Band Width** - Boh-4-Band<sup>10</sup> is available in  $^3$ a" and  $1^1$ a" band widths and many lengths for nounting a variety of equipment. Generally, use  $^3$ a" band for lighter loads (cabinets telephone drops U-Guards co-axial cable etc.), and  $1^1$ a" band for high tension loads.

Bank Length - Proper length is easily determined by placing equipment to insurted against pole or effucture at mounting poertion. Measure total length needed around structure add are (6) inches and round up to need standard length to determine correct length to order firstallation instructions are always included with each Boil-A-Band "croter."

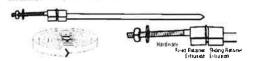








CATALOG +	AN THOISTE	GARTON	DESCRIPTION
CTR	216 Sts	100	Should Cath To Retains to one over some for over 10 Tests

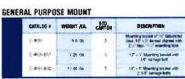

TRANSFORMER MOUNTING BRACKET MEADON WENDER ILA CAPTON

6184











CATALOG #	SPEIGHT /EA	CARTON	DESCRIPTION
C TR	210 Bu	100	Booked Capts The Returbine Res and with proper Politics To 1/17/2018.









WEIGHTALA CARTON NARDWARE LENDTH BARE



Aliminim Hardware Estriction 6/61/16 Aliminion ABA - Itos ales conforms In ASTM 8/221 A marinion tension strength 56/00/PS 1, and minimum swidstrength of 35/00/PS Carriage Soil - High streight Glaze 5 carriage had (ASTM A 440). Turnstred the Carriage in Colores

STANDARD 100'

Ų	ENGTH E	BANDS				BUCK	LES FOR	100' B	ANDS
	BACH	CANTON	HARDWAFE	LEMSTH	BANKO		CATALOG #	WENCH	EASTON
x	8.00 me	- 3	45°	100	475		EAR 30	5 84	24
00	10:00 bs	1/4	100	120	100	0	848 M	1.25 Bi.	74
_			_						

TANDARD LENGTH DOUBLE BAND							
	CATALOG +	WEIDHT/EA.	call on	HARDWARE	LEMETH	BAND	
	PAB 15836-2	3 50 R	24	14.	36	10"	
	EXE BAS 2	4 00 Br	24	45	45	180	
	248 5863.7	7.50 B	24	40	54	200	

STANDARD LENGTH SINGLE BAND

CATALOD 4 1 - 201 GSE-10 1 - 201 GSE-10

BANDING STRENGTH TESTS	BAND STRENGTH WITH ALUMINUM OR Steel alloy fittings
MAXIMUM BAND CAPACITY	ALLEGO LILL CHARGO

KIMUM BAND CAPACITY  I had yeare during ace with special large steet halings stack the maximum recommended load right of the essisted banes. Animalism of all latings, size as the Adibb to the ace goverably washed than these calles for	STEEL ALLOY FITTINGS  WITTING WINTS - MIGHENMAN FOLL - LIM.  Discussion - Limits - L
per farchers (contact the tatlory	D THY SAMON
CO C	1 to AMES  W BARES  ( ASSET  ) To AMES



	Tie Hetainer
	255
	<b>1</b> 0
_	





ALL P	OWLASE WIL	. DANGAL	I (IDCAIRS S	- ec(1)
	CATALOD P	WEIGHT	CARFOR	DESC
	100			Colomo dia

CATALOG P	WESHT	CARTON	DESCRIPTION
59.1211.0	A0 to	24	Note that Wall and
H088/15/EH	#5 (b)	24	man taly black
1298-1518-014	1.00 m	24	many linky thropic men farmed 1 Mile 1 (Kull
100815184034	36 lb.	žŧ	ent Committee although
80.21 58.2	SAR IS	- 12	he cast ago 3 y thrus- with exercise to a 2 for

Assumes well that Book

#### RANDED CITY ATTACHMENT WITH CLEVIS

CARALDO #	WEIGHT ALS.	CARTON	BESCRIPTION
50A 11	1 90 to	24	dispute facts disputer in the special state of the public forms of the special special state of the special sp
15A-520	2 90 to	24	Huma Bury Sounce (see American) and (see)
364 325	4 259 Ibi	21	have move they have they it has more


60-0

Moneting Bracket (MISS Series shown)

6



		878	DESCRIPTION			
CATALOG #	WEIGHT ÆA.	CARTEM	FOR			
555-1	17 to	24	T.	55.9	thi	
EH.7	11 Em.	74	2	211	297	
547.9	15 be	24	3"	347	397	
641.4	17 kg	24	a*	100	Pic.	
252.5	73 Pv.	24	:51	9000	57%	
2124	27 thi	24	.0"	\$25	Cir	

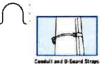

IT IS A VIOLATION OF LAW FOR ANY PERSON, UNLESS HEY ARE ACTING UNDER THE DIRECTION OF A LICENSE PROFESSIONAL ENGINEER, TO ALTER THIS DOCUMENT.

CRAN\_RSFR\_SAC01\_017

POLE # 352221

IN THE PUBLIC R.C.W.

8661 POWER INN RD ELK GROVE, CA 95624

at&t

Vinculums

M SQUARED

1387 CALLE AVANZADO

1 12/04/2019 100% CD'S FOR SUBMITTAL 11/21/2019 100% CO'S FOR REVIEW

B 11/01/2019 95% CD'S FOR REVIEW A D9/16/2019 90% CD'S FOR REVIEW

REV DATE DESCRIPTION

DRAWN BY:

CHECKED BY

14807730


мм


BOLT-A-BAND DETAIL

SHEET NUMBER

**D-3** 

**BOLT-A-BAND DETAIL** 

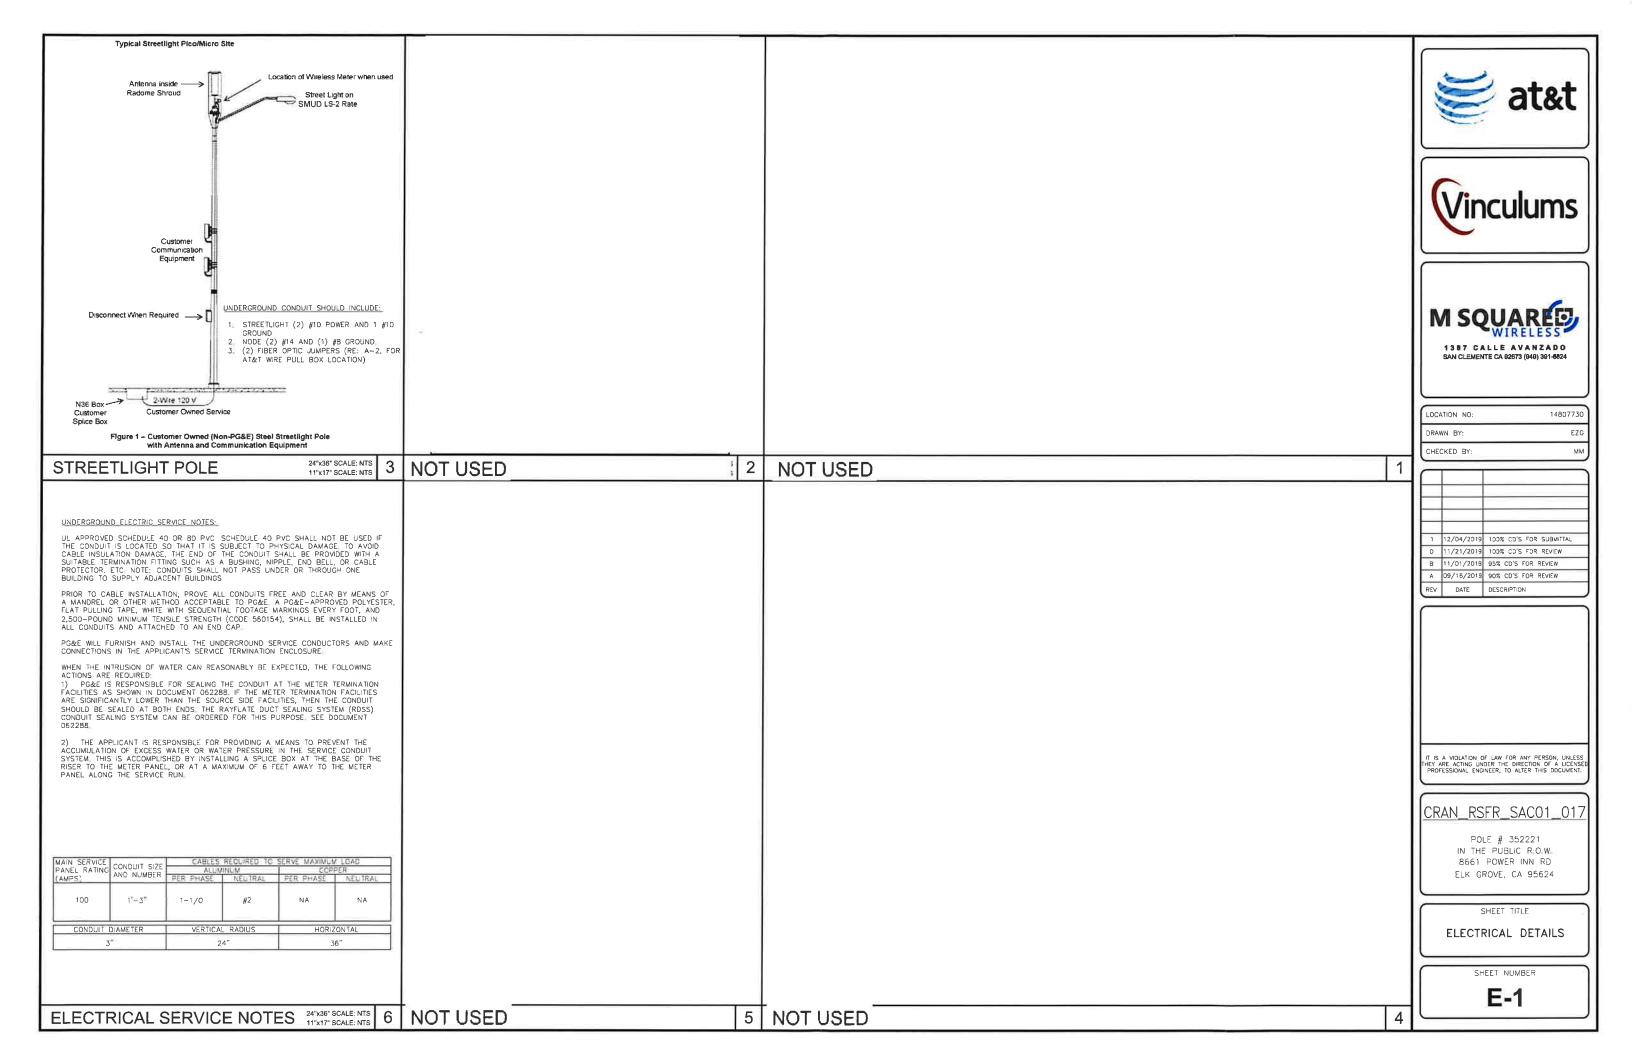

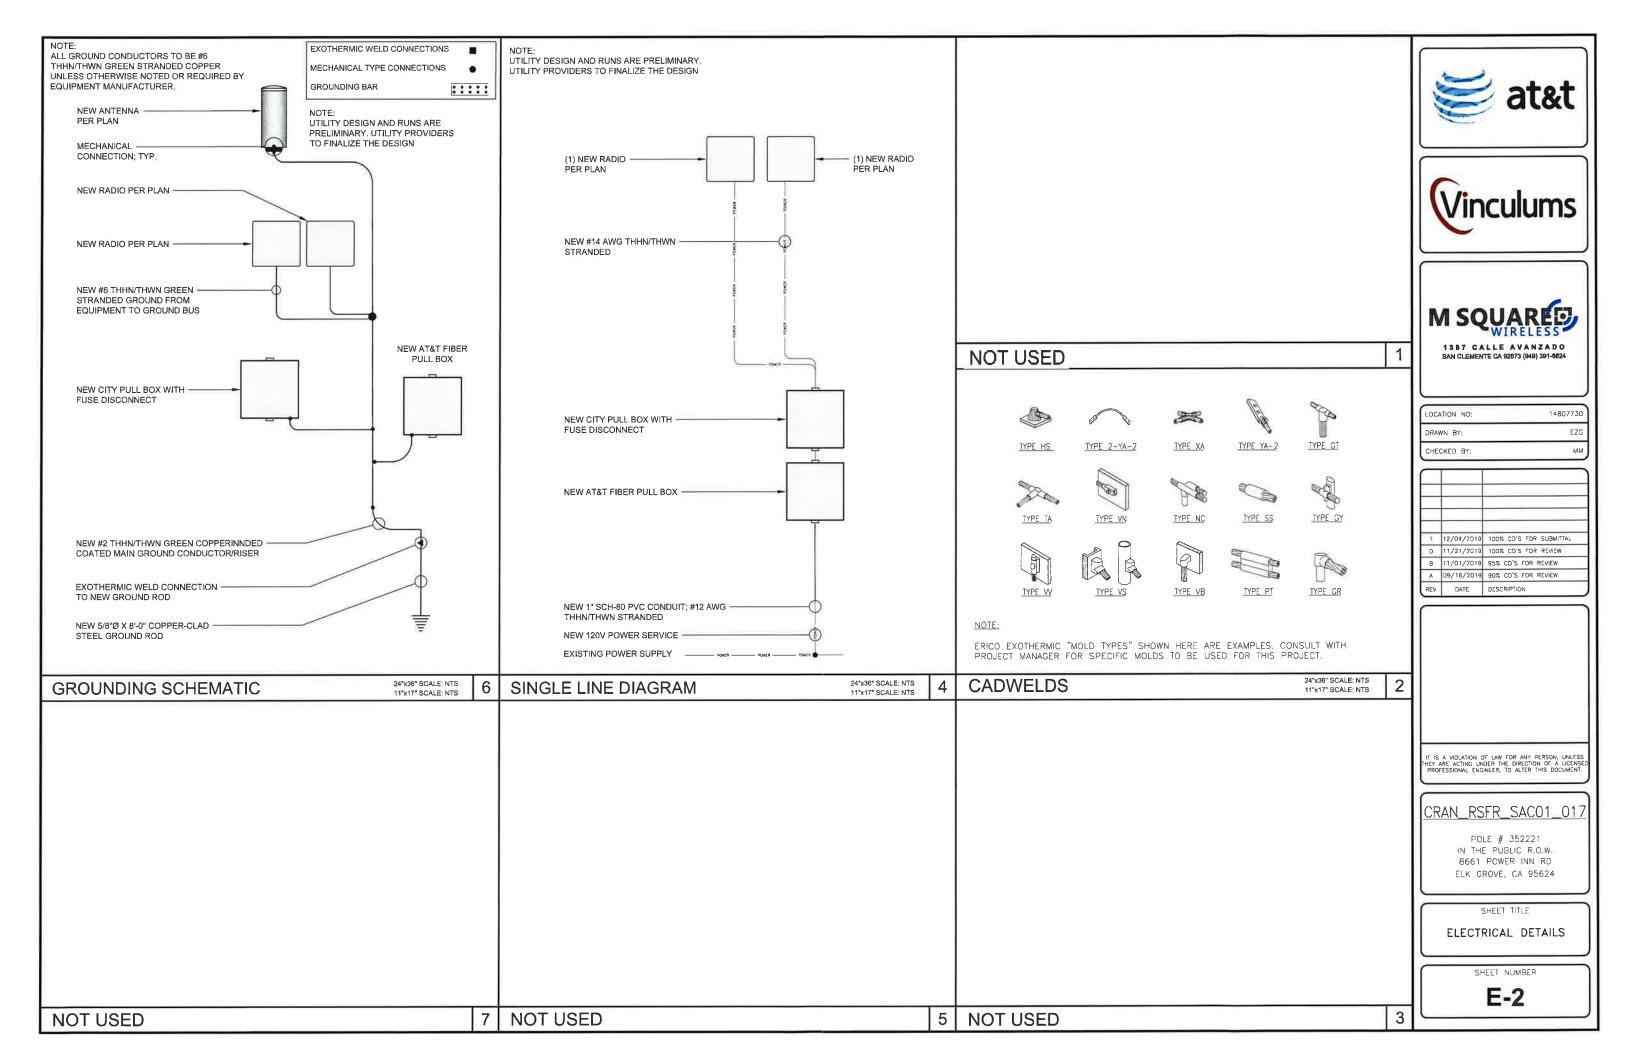

#### MUTCD REFERENCE GUIDE:

- 1. NOTHING ALLOWED IN THE BUFFER AND TRANSITION AREAS AT ALL TIMES.
- 2. SIGNS ARE ONLY SHOWING TO THE PUBLIC WHEN IN USE:
- 3. SIGNS AND CHANNELIZING DEVICES MUST BE RETROREFLECTIVE OR ILLUMINATED DURING
- 4. SIGN PANEL SIZES 36"X36" MIN. ON ROADS <50MPH, 48"X48" ON ROADS >50MPH.
- 5. SIGNS ARE SPACED PER THE CA 2014 MUTCD (REVISION 2) MANUAL.
- 6 CHANNELIZING DEVICES SPACING AND TAPER LENGTHS ARE BASED ON THEIR RESPECTIVE CHARTS.
- 7. NOTIFY THE LOCAL LAW ENFORCEMENT, FIRE AND AMBULANCE COMPANIES WITHIN 72 HOURS BEFORE CONSTRUCTION BEGINS.
- 8. CONTRACTOR TO MAKE SURE ALL TRAFFIC CONTROL EQUIPMENT MEETS ALL AGENCY REQUIREMENTS.
- 9. REMOVE ALL CONFLICTING MARKINGS FOR LONG TERMS OPERATIONS (3 DAYS OR LONGER).
- 10. THE LOCATION OF THE SIGNS AS SHOWN ON THE ILLUSTRATIONS ARE GUIDELINES AND ACTUAL LOCATIONS WILL DEPEND UPON ALIGNMENT, GRADE, LOCATIONS OF STREET INTERSECTIONS AND 85% TILE POSTED SPEED LIMITS.
- 11. WHILE CROSSING INTERSECTIONS DURING MOBILE WORK, WORK MUST FOLLOW THE FLOW OF TRAFFIC AND PROCEED ON A GREEN LIGHT.
- 12. FULL COMPLIANCE IS REQUIRED WITH THE CITY AGENCY.
- 13, PEDESTRIAN ACCESS MUST BE MAINTAINED AS PER THE CA 2014 MUTCD (REVISION 2) STANDARDS AND ADA REQUIREMENTS.
- 14, C30 SIGNS ARE PERMITTED IN BUFFER AREAS.
- 15, SIGN SPACING IS PROVIDED IN THE CA MUTCD 2014 EDITION (REVISION 2), PART 6, TRAFFIC SPEEDS ARE BASED UPON RADAR MEASUREMENTS OF MOTORISTS, THE MUTCD ALLOWS FOR A "RANGE" IN SIGN PLACEMENT AND WILL BE PROVIDED BY DOT, THE 85% TILE IS USED WHEN AVAILABLE TO PROVIDE A MORE ACCURATE PRESENTATION OF MOTORISTS SPEEDS.
- 16, ANY WORK WITHIN 200FT OF A SIGNALIZED INTERSECTION WILL REQUIRE CONTACT AND COORDINATION WITH CITY AGENCY PRIOR TO ANY WORK.
- 17, QUALITY STANDARDS TO MEET REQUIREMENTS OF SECTION 1A-2 OF THE CALIFORNIA MANUAL ON UNIFORM TRAFFIC CONTROL DEVICES.
- 18, ALL TRAFFIC CONTROL DEVICES INCLUDING: SIGNS, BARRICADES, VERTICAL PANELS, DRUMS, WARNING LIGHTS, ARROWBOARDS, CHANGEABLE MESSAGE SIGNS, CONES AND TUBULAR MARKERS THAT MEET THE REQUIREMENTS OF AMERICAN TRAFFIC SAFETY SERVICES ASSOCIATION (ATSSA). CA MUTCD 2014 (REVISION 2) SHALL BE USED ON THIS PROJECT/THIS WORK.
- 19. THE NCHRP REPORT 476 PROVIDES GUIDELINES FOR DESIGN AND OPERATION OF NIGHTTIME TRAFFIC CONTROL FOR HIGHWAY MAINTENANCE AND CONSTRUCTION, SEE TYPICAL APPLICATIONS NWTA-1 THROUGH NWTA-7, COMPLY WITH ANSI 107-2004 FOR APPAREL HIGHWAY CONSTRUCTION WORK LIGHTING SHALL BE PER CONSTRUCTION SAFETY ORDER 1523 ILLUMINATIONS.
- 20. SIDEWALKS AT THE CONSTRUCTION LOCATION MAY BE CLOSED WITH ADEQUATE DETOURS, SIDEWALKS MAY ONLY BE CLOSED TO THROUGH TRAFFIC AND SHALL NOT PREVENT LOCAL PEDESTRIANS ACCESS, DETOURS SHALL NOT INCREASE THE PATH OF TRAVEL BY MORE THAN 500FT, DETOUR ROUTES SHALL BE LIMITED TO EXISTING SIDEWALKS, PRIVATE PROPERTIES (SEE BELOW REQUIREMENTS) AND CROSSINGS AT ROADWAY INTERSECTIONS. TO THE MAXIMUM EXTENT FEASIBLE, THE ALTERNATE CIRCULATION PATH SHALL BE PROVIDED ON THE SAME SIDE OF THE STREET AS THE DISRUPTED ROUTE, WHERE IT IS FEASIBLE TO PROVIDE A SAME—SIDE ALTERNATE CIRCULATION PATH AND PEDESTRIANS WILL BE DETOURED, SECTION 60,02 OF THE CA 2014 MUTCD (REVISION 2) SPECIFIES THAT THE ALTERNATE PATH PROVIDE A SIMILAR LEVEL OF ACCESSIBILITY TO THEAT OF THE EXISTING DISRUPTED ROUTE, THIS MAY INCLUDE THE INCORPORATION OF ACCESSIBLE PEDESTRIAN SIGNS (APS), CURB RAMPS, OR OTHERS ACCESSIBILITY FEATURES.
- 21. PEDESTRIANS MAY BE DETOURED ONTO PRIVATE PROPERTY ONLY IF WRITTEN PERMISSION FROM THE PROPERTY WONDER IS OBTAINED ALONG WITH DOCUMENTATION INDICATING THAT THE CITY WOULD NOT BE LIABLE (HOLD HARMLESS) IN THE EVENT OF AN ACCIDENT.
- 22. DURING WORK HOURS, AT LEAST ONE WORKER SHALL BE ASSIGNED THE RESPONSIBILITY TO ESCORT ELDERLY, DISABLED OR ANY OTHER PEDESTRIANS IN NEED OF ASSISTANCE THROUGH THE CONSTRUCTION SITE, A WORKER ASSIGNED WITH THIS RESPONSIBILITY MAY ALSO PARTICIPATE IN OTHER CONSTRUCTION ACTIVITIES; HOWEVER, THE ASSIGNED WORKER SHALL BE AWARE OF HIS OR HERS RESPONSIBILITIES FOR PROVIDING THIS ASSISTANCE, MEASURES THAT SIMPLY CLOSE THE SIDEWALK, WITH THE EXCEPTION THAT PEDESTRIANS WILL CROSS SOMEWHERE ELSE DOES NOT ADEQUATELY SATISFY PEDESTRIAN ACCESS. PEDESTRIANS SHOULD NEVER BE DIRECTED/EXPECTED TO CROSS A MULTILANE ROADWAY AT ANY LOCATION OTHER THAN AT A SIGNAL (OR ALL-WAY STOP). ACCOMMODATIONS SHOULD BE MADE ON THE SAME SIDE OF ROADWAY AS WORK.

#### TRAFFIC CONTROL NOTES:

- 1. IT IS THE RESPONSIBILITY OF THE CONTRACTOR PERFORMING WORK ON A PUBLIC STREET TO INSTALL AND MAINTAIN THE TRAFFIC CONTROL DEVICES AS SHOWN HEREIN, AS WELL AS ANY ADDITIONAL TRAFFIC CONTROL DEVICES THAT MAY BE REQUIRED TO INSURE THE SAFE MOVEMENT OF TRAFFIC AND PEDESTRIANS THROUGH OR AROUND THE WORK AREA AND PROVIDE MAXIMUM PROTECTION AND SAFETY TO CONSTRUCTION WORKERS.
- 2. ALL DELINEATORS SHALL BE EQUIPPED WITH REFLECTORS AT NIGHT TIME,
- 3. THE CONTRACTOR SHALL NOTIFY THE CITY/COUNTY OF RECORD AND CALTRANS PERMIT INSPECTOR AT LEAST FIVE WORKING DAYS IN ADVANCE OF IMPLEMENTING ANY CONSTRUCTION DETOUR.
- 4. ALL SIGNS, DELINEATORS, BARRICADES, ETC. AND THEIR INSTALLATION SHALL CONFORM TO THE MANUAL OF UNIFORM TRAFFIC CONTROL DEVICES (LATEST EDITION) AND THE MUTCD CALIFORNIA SUPPLEMENT, STATE OF CALIFORNIA STANDARD SPECIFICATIONS, SPECIAL PROVISIONS, AND STAMPED PLANS.
- 5. THE CITY/COUNTY OF RECORD AND CALTRANS RESERVE THE RIGHT TO OBSERVE THESE TRAFFIC CONTROL PLANS IN USE AND TO MAKE ANY NECESSARY CHANGES AS FIELD CONDITIONS WARRANT, ANY CHANGES SHALL SUPERSEDE THESE PLANS, EXACT LOCATION OF ALL EQUIPMENT AND TRAFFIC CONTROL DEVICES SHALL BE DETERMINED BY THE ENGINEER.
- 6. ALL TRAFFIC CONTROL DEVICES, STRIPES, MARKINGS, LEGENDS AND RAISED PAVEMENT MARKERS SHALL CONFORM TO THE MUTCD AND THE CALIFORNIA SUPPLEMENT (LATEST EDITION), THE STATE OF CALIFORNIA STANDARD SPECIFICATIONS (LATEST EDITION), SPECIAL PROVISIONS, AND STAMPED PLANS.
- 7. ALL TRAFFIC CONTROL DEVICES SHALL BE KEPT IN THEIR POSITION AT ALL TIMES AND SHALL BE REPAIRED, REPLACED OR CLEANED AS NECESSARY TO PRESERVE THEIR APPEARANCE AND CONTINUITY.
- 8; ALL TRAFFIC LANES SHALL HAVE A MINIMUM OF 5 FEET CLEARANCE FROM OPEN EXCAVATIONS AND A MINIMUM OF 2 FEET FROM VERTICAL OBSTRUCTIONS.
- CONTRACTOR SHALL PROVIDE FLAGGERS AS DEEMED NECESSARY BY THE CITY/COUNTY INSPECTOR OR CALTRANS PERMIT INSPECTOR.
- 10 ALL ADVANCE WARNING SIGNS SHALL BE EQUIPPED WITH FLAGS.
- 11. TRAFFIC SIGNALS SHALL REMAIN IN OPERATION AT ALL TIMES, SIGNAL OPERATION DURING EACH
  CONSTRUCTION PHASE SHALL BE COORDINATED WITH AND APPROVED BY THE CITY/COUNTY OF RECORD
  AND/OR CALTRANS INSPECTOR.
- 12. PLACE ADDITIONAL "LANE CLOSED", (C30) SIGNS ON TYPE II BARRICADES AT 100 FOOT INTERVALS
  THROUGHOUT EXTENDED WORK AREAS IN EACH LANE THAT IS CLOSED, INSTALL "OPEN TRENCH" (C27)
  SIGNS WHENEVER AN OPEN EXCAVATION AREA EXISTS ADJACENT TO THE TRAVELED WAY.
- 13. ALL TEMPORARY TRAFFIC CONTROL DEVICES SHALL BE REMOVED FOLLOWING COMPLETION OF EACH CONSTRUCTION STAGE AND THE PERMANENT TRAFFIC CONTROL DEVICES SHALL BE RESTORED BY THE CONTRACTOR UPON COMPLETION OF PROJECT.
- 14 CONTRACTOR SHALL REPLACE/REPAIR ALL DAMAGED STRIPING AT THE END OF EACH WORKING DAY.
- 15. CONTRACTOR SHALL COMPLY WITH THE REQUIREMENTS OF THE AMERICAN DISABILITY ACT AS RELATED TO PEDESTRIAN ACCESS AND SHALL MAINTAIN PEDESTRIAN ACCESS AT ALL TIMES PER ADA REQUIREMENTS. SIDEWALK CLOSURE/DETOUR SHALL COMPLY WITH THE WATCH STANDARDS AND MUST OBTAIN APPROVAL FROM THE CITY/COUNTY OF RECORD.
- 16. CONTRACTOR SHALL COVER OR REMOVE ALL CONFLICTING SIGNS.
- 17. CONTRACTOR SHALL POST "SYMBOL" UNEVEN LANES, "STEEL PLATES AHEAD" OR "BUMP" SIGNS FOR PAVEMENT SURFACE DISRUPTIONS OF 1/2" OR GREATER, PAVEMENT DISRUPTIONS FOR 1" OR GREATER SHALL HAVE A BEVELED EDGE OF FOUR (4) HORIZONTAL TO ONE (1) VERTICAL.
- 18, CONTRACTOR SHALL INSTALL "CAUTION STEEL PLATES AHEAD" AND/OR "ROUGH ROAD" SIGNS IN ADVANCE OF STEEL PLATE BRIDGING.
- 19, CONTRACTOR SHALL VERIFY ALL NECESSARY EQUIPMENT NEEDED FOR OVERHEAD CONSTRUCTION PRIOR TO THE START OF CONSTRUCTION.
- 20. WORK HOURS SHALL COMPLY WITH CITY OF ELK GROVE CONSTRUCTION CODE AND SCC CHAPTER 10.16 TRAFFIC CONTROL DEVICES.
- 21. RESIDENTS TO BE NOTIFIED OF DATES AND TIMES OF CONSTRUCTIONS TWO (2) WEEKS PRIOR TO THE START OF WORK.
- 22. A 5'-0" MIN, PEDESTRIAN CLEARANCE TO BE MAINTAINED AT EXISTING SIDEWALKS,
- 23. POSTED SPEED 30MPH ON POWER INN RD

						Ta	Minimu aper Ler								
Posted Speed	Formula	Buffer Space											mum Spacing	Sign Spacing	LIDG (Ft)
			L	½ L	1/3 L	L	½ L	1/3 L	L	½ L	1/3 L			$\triangle$	
25		155'	104'	52'	35'	115'	57'	38'	125'	63'	42'	25'	13'	100' To 200'	94'
30	1 1002	200'	1501	75'	50'	165'	83'	55'	180'	90'	60'	30'	15'	120' To 250'	113'
35	$L = \frac{WS^2}{60}$	250'	204'	102'	68'	225'	112'	75'	245'	123'	82'	35'	18'	140' To 280'	131'
40	60	305	267'	133'	89'	293'	147'	98'	320'	160'	107'	40'	20'	160' To 320'	150'
45		360'	450'	225'	150'	495'	248'	165'	540'	270'	180'	45'	23'	360' To 540'	169'
50		425'	500'	250'	167	550'	275	183	600'	300'	200'	50,	25'	400' To 600'	197'
55		495'	550'	275'	183'	605'	303'	202'	660'	330'	220'	50'	28'	440' To 660'	210'
60	L = WS	570'	600'	300'	200'	660'	330'	220'	720'	360"	240'	50'	30'	480' To 720'	225'
65		645'	650'	325'	217'	715'	358'	238'	780	390'	260'	50'	33'	520' To 700'	244'
70		730'	700'	350'	233'	770'	385'	257'	840'	420'	280'	50'	35'	560' To 820'	263'







14807730

DRA	WN BY:	EZG
CHE	CKED BY:	MM
_		
1	12/04/2019	100% CD'S FOR SUBMITTAL
0	11/21/2019	100% CD'S FOR REVIEW
В	11/01/2019	95% CD'S FOR REVIEW
A	09/16/2019	90% CD'S FOR REVIEW

DATE DESCRIPTION

LOCATION NO

IT IS A VIOLATION OF LAW FOR ANY PERSON, UNLESS HEY ARE ACTING UNDER THE DIRECTION OF A LICENSE PROFESSIONAL ENGINEER, TO ALTER THIS DOCUMENT

CRAN\_RSFR\_SAC01\_017

POLE # 352221
IN THE PUBLIC R.C.W.
8661 POWER INN RD
ELK GROVE, CA 95624

SHEET TITLE

TRAFFIC CONTROL PLAN NOTES

SHEET NUMBER

TCP-1

ALL TRAFFIC CONTROL SHALL COMPLY WITH ALL CITY OF ELK GROVE REQUIREMENTS. SEE ATTACHED MUTCD REFERENCE GUIDE FOR INFORMATION ON SIGN SPACING, LOCATION, OF CONSTRUCTION SIGNAGE, FLAGGERS, AND CHANNELING DEVICES

ALLOWABLE WORKING HOURS M-F: 8:30AM - 3:30PM SAT: 7:00AM - 5:00PM

CONTRACTOR TO PROVIDE PEDESTRIAN ESCORT

MAINTAIN ACCESS TO R/T BUS STOPS OR COORDINATE WITH R/T TO RELOCATE BUS STOP LOCATIONS CONTRACTOR SHALL COORDINATE THE BUS STOP WITH R/T REPRESENTATIVE. (916) 321-2800

\*POST TEMPORARY NO PARKING SIGN ON TYPE BARRICADE 72 HRS IN ADVANCED.

TRAFFIC CONTROL TO BE ARRANGED 72 HOURS IN ADVANCE OF CONSTRUCTION







H	LOCATION NO:	14807730
П	DRAWN BY:	EZG
	CHECKED BY:	ММ

_		
1	12/04/2019	100% CD'S FOR SUBMITTAL
D	11/21/2019	100% CD'S FOR REVIEW
В	11/01/2019	95% CD'S FOR REVIEW
Α	09/16/2019	90% CD'S FOR REVIEW
REV	DATE	DESCRIPTION

IT IS A VIDLATION OF LAW FOR ANY PERSON, UNLESS HEY ARE ACTING UNDER THE DIRECTION OF A LICENSE PROFESSIONAL ENGINEER, TO ALTER THIS DOCUMENT

## CRAN\_RSFR\_SAC01\_017


POLE # 352221 IN THE PUBLIC ROW 8661 POWER INN RD ELK GROVE, CA 95624

SHEET TITLE

TRAFFIC CONTROL PLAN

SHEET NUMBER

TCP-2

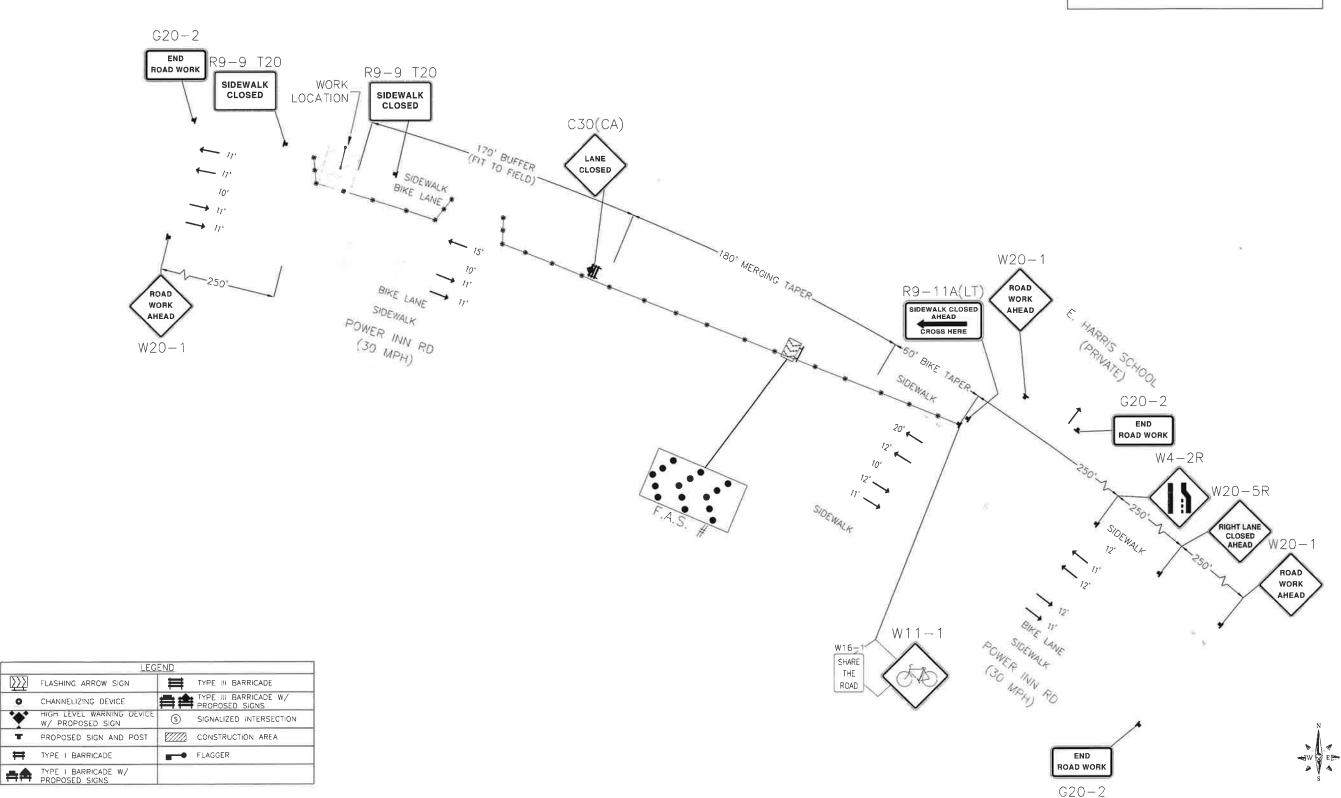

0